

# **HOSPITAL SITE LOCATION**

LA: 2° 21' 17.75" N

Long: 45° 23' 13.81" E

### **Notes**

- 1. All dimensions are to be checked on site. Any discrepancy indimensions is to be reported to the architect before anywork commence. The Architect's drawings and specifications over rule any other. the Structural Engineers detail drawings.
- All construction work to comply with the international standards codes protection.
- 3. The PV denotes permanent ventilation and must be provided above alldoors and windows where indicated.
- 4. All walls less than 200mm thick are to be reinforced with hoop iron sheet every alternate course.
- 5. All reinforced concrete works to be done according to structural detail drawings

i		No:	Date:	Description:
i				
į				
				REVISION

#### Implemented by:



International Organization for Migration (IOM
The UN Migration Agency

#### Client





THE FEDERAL REPUBLIC OF SOMALIA

HIRSHABELLE STATE, BALCAD DISTRICT

roject Title

PROPOSED CONSTRUCTION OF HOSPITAL PHASE #1- IN BALAD DISTRICT, HIRSHABELLE STATE, SOMALIA

Drawing T

### SITE LOCATION


DATE: MAY 2019

DRAWN BY: ENG. Duale Salah

REVIEWED BY:

Sheet No

.

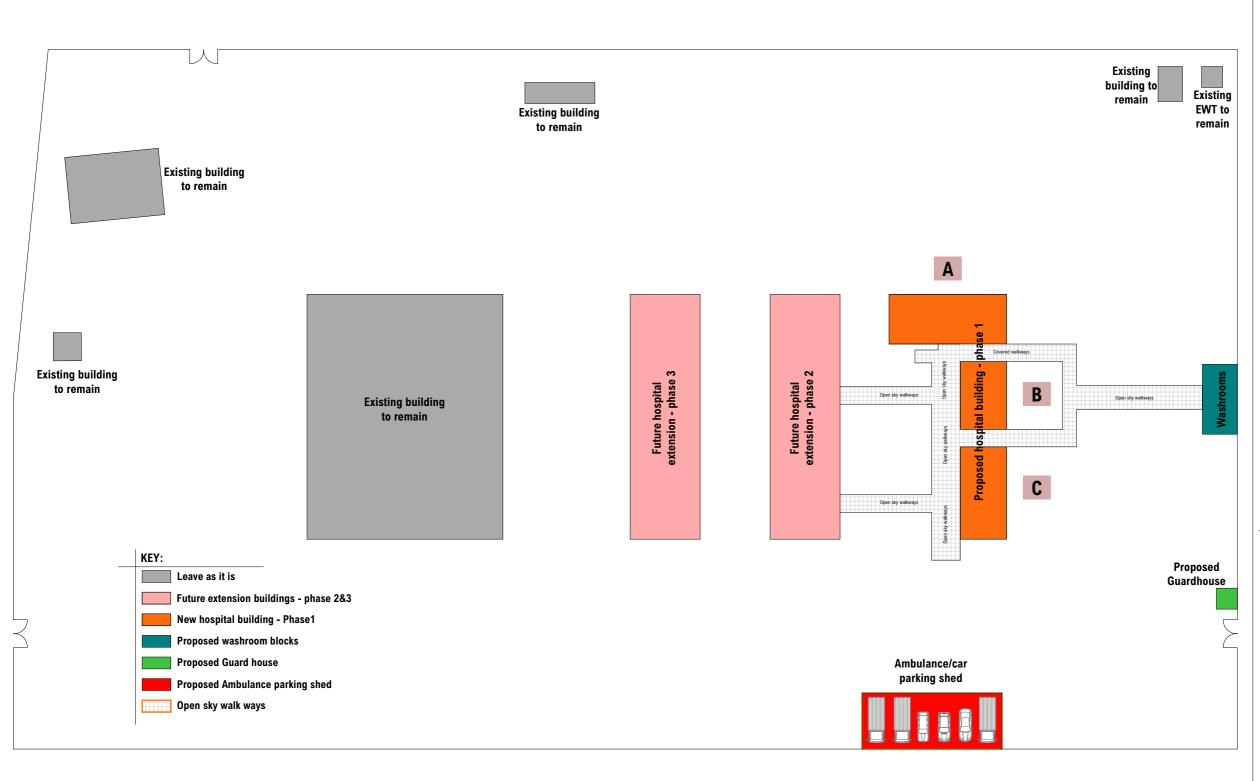


- All dimensions are to be checked on site. Any discrepancy indimensions is to be reported to the architect before anywork commence. The Architect's drawings and specifications over rule any other, the Structural Engineers detail drawings.
- 2. All construction work to comply with the international standards codes protection.
- 3. The PV denotes permanent ventilation and must be provided above alldoors and windows where indicated.
- 4. All walls less than 200mm thick are to be reinforced with hoop iron sheet every alternate course.
- 5. All reinforced concrete works to be done according to structural detail drawings

No:	Date:	Description:
		REVISION



<u>A3</u>

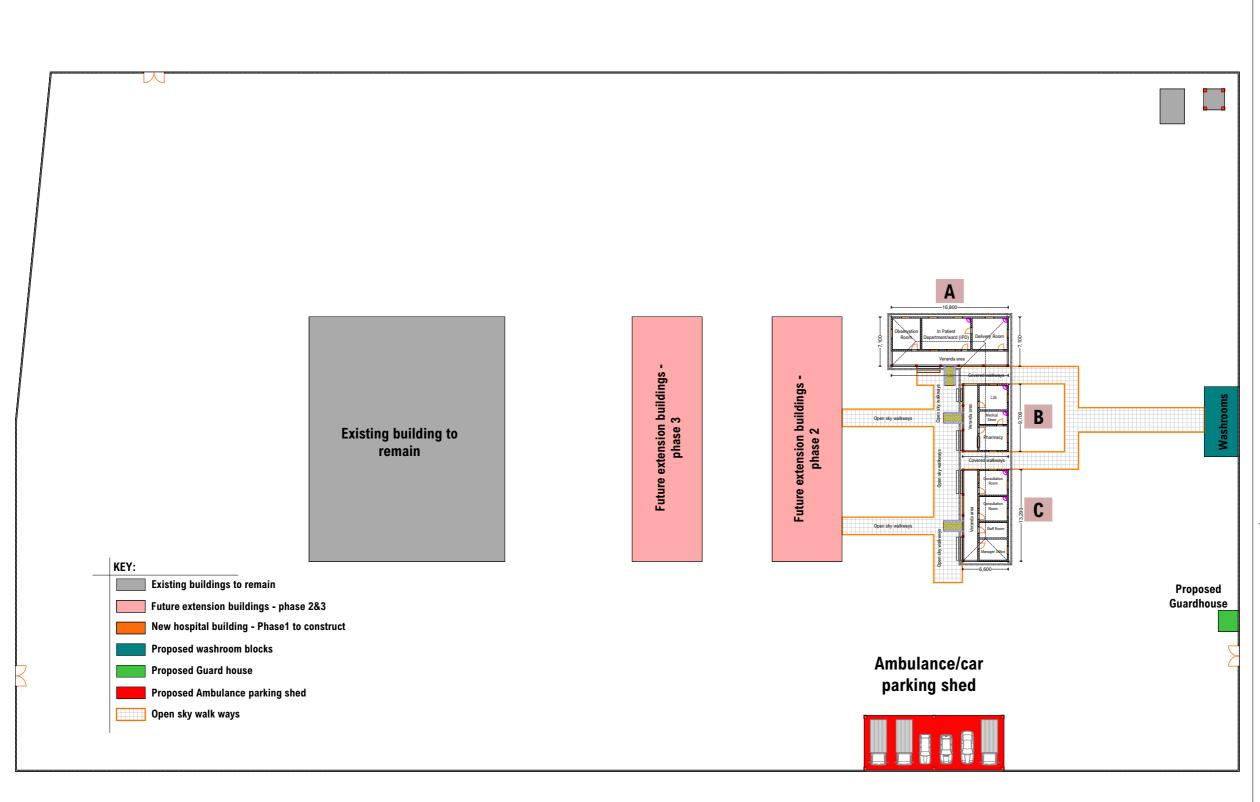

- All dimensions are to be checked on site. Any discrepancy indimensions is to be reported to the architect before anywork commence. The Architect's drawings and specifications over rule any other, the Structural Engineers detail drawings.
- 2. All construction work to comply with the international standards codes protection.
- 3. The PV denotes permanent ventilation and must be provided above alldoors and windows where indicated.
- 4. All walls less than 200mm thick are to be reinforced with hoop iron sheet every alternate course.
- 5. All reinforced concrete works to be done according to structural detail drawings

No:	Date:	Description:
		REVISION



Client





THE FEDERAL REPUBLIC OF SOMALIA

**OF** HIRSHABELLE STATE, BALCAD DISTRICT

roject Title

PROPOSED CONSTRUCTION OF HOSPITAL-Phase #1- in Balad District, Hirshabelle State, Somalia

Drawing Title

SITE PLAN

ENG. Duale Salah


SCALE: AS SHOWN

DATE: MAY 2019

REVIEWED BY:

Sheet No.

<u>A3</u>

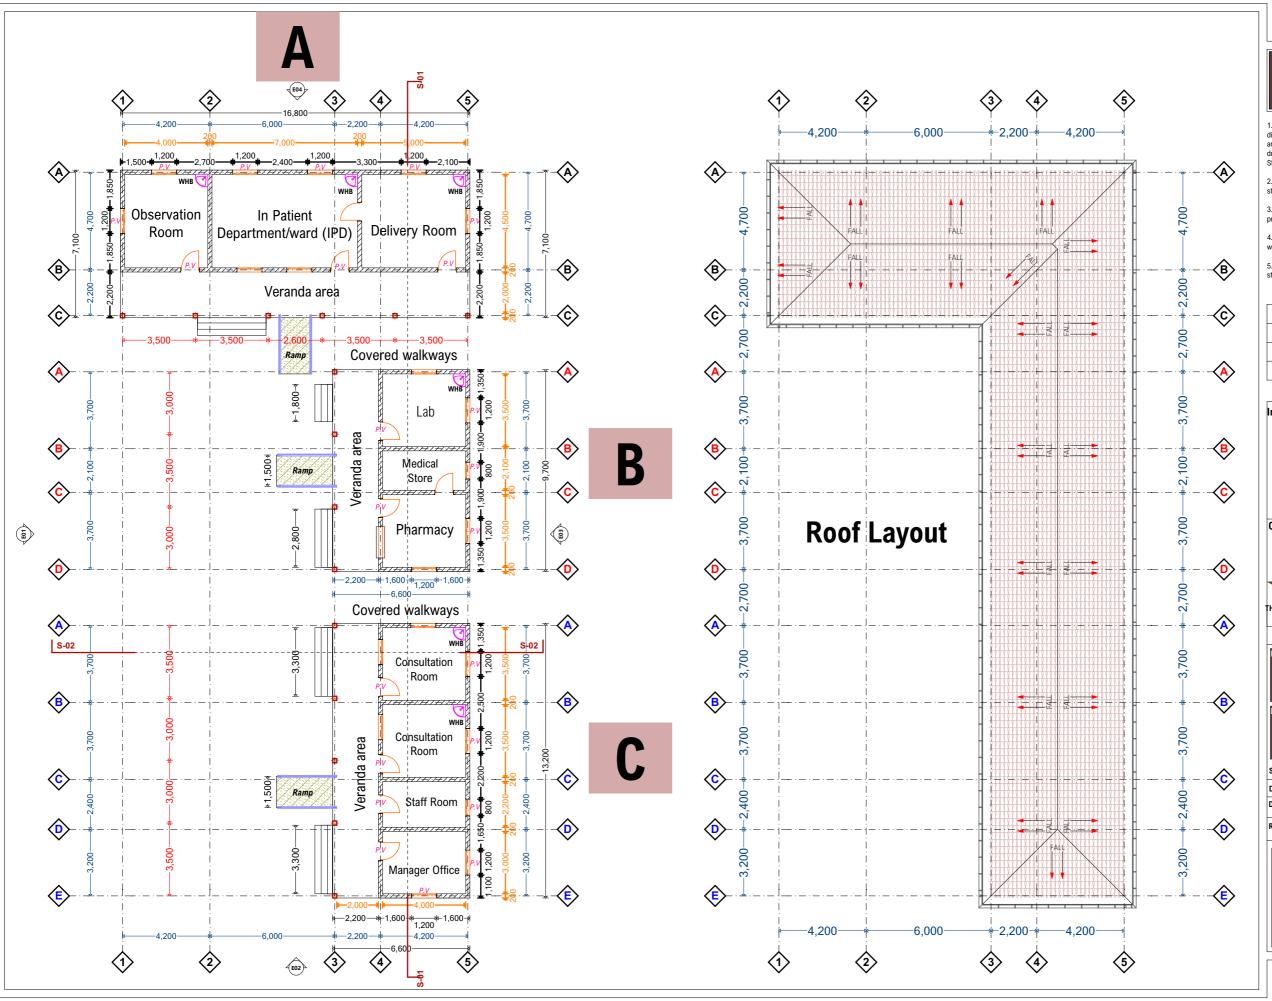

- All dimensions are to be checked on site. Any discrepancy indimensions is to be reported to the architect before anywork commence. The Architect's drawings and specifications over rule any other, the Structural Engineers detail drawings.
- 2. All construction work to comply with the international standards codes protection.
- 3. The PV denotes permanent ventilation and must be provided above alldoors and windows where indicated.
- 4. All walls less than 200mm thick are to be reinforced with hoop iron sheet every alternate course.
- 5. All reinforced concrete works to be done according to structural detail drawings

No:	Date:	Description:
		REVISION





The UN Migration Agency

Client:





THE FEDERAL REPUBLIC OF SOMALIA

HIRSHABELLE STATE, BALCAD DISTRICT

roject Title

PROPOSED CONSTRUCTION OF HOSPITAL-PHASE #1- IN BALAD DISTRICT, HIRSHABELLE STATE, SOMALIA

Drawing Titl

### **FLOOR PLAN**

DATE: AS SHOWN


DATE: MAY 2019

DRAWN BY: ENG. Duale Salah


REVIEWED BY:


Sheet No.


<u>A</u>:

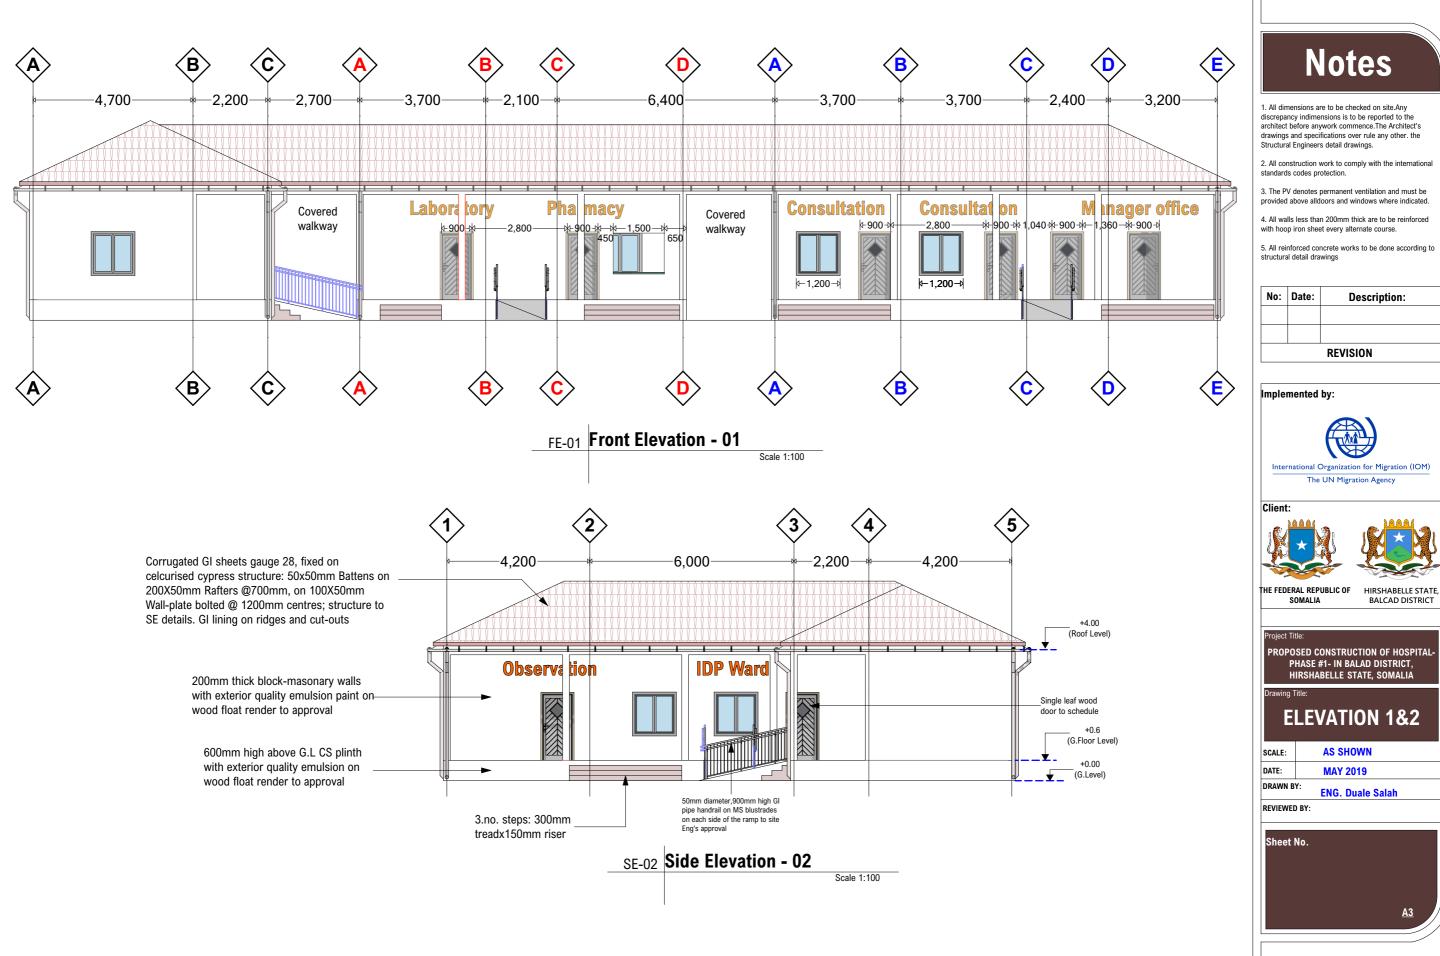


No:	Date:	Description:
		REVISION

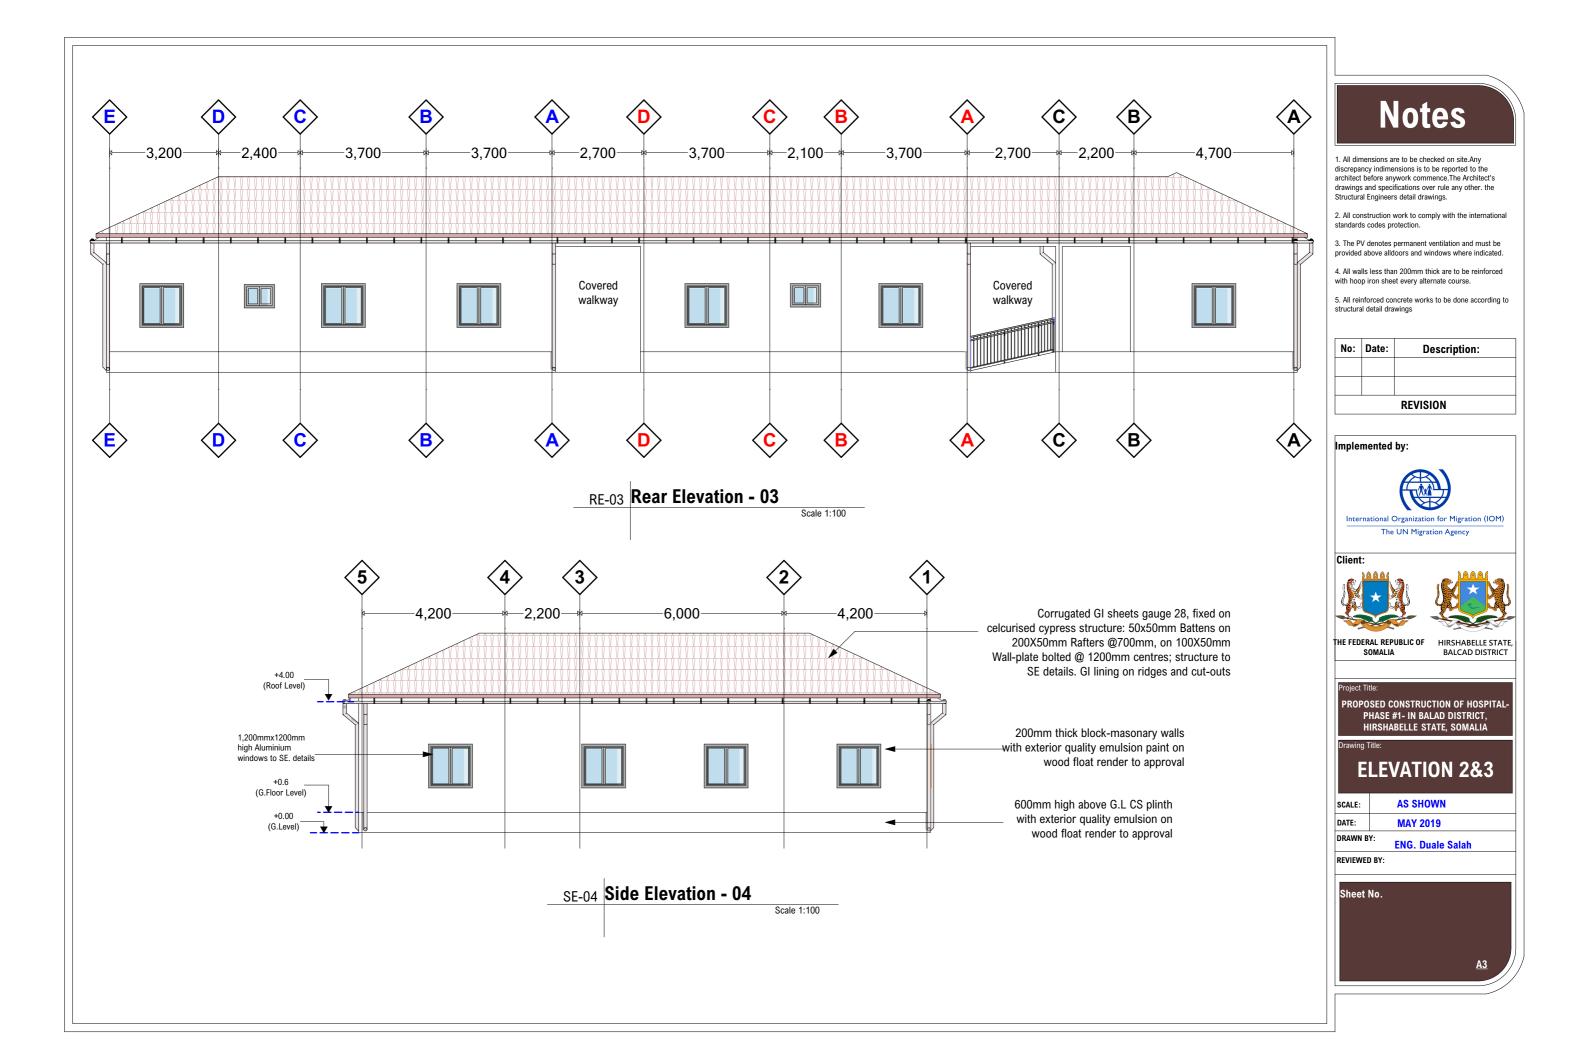

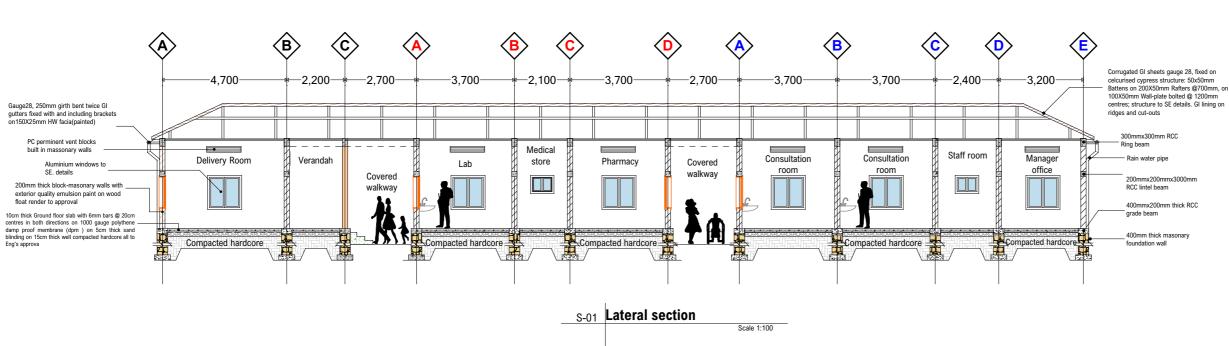


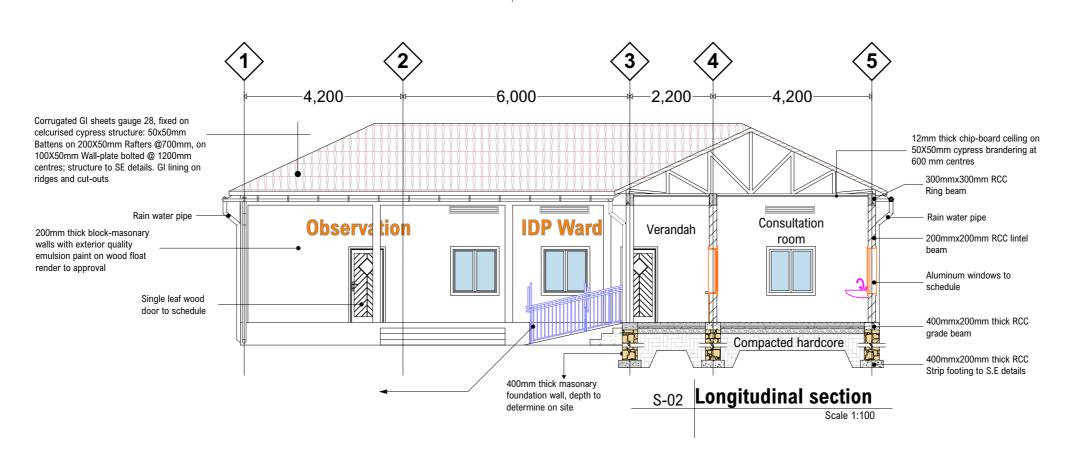

- All dimensions are to be checked on site. Any discrepancy indimensions is to be reported to the architect before anywork commence. The Architect's drawings and specifications over rule any other. the Structural Engineers detail drawings.
- 2. All construction work to comply with the international standards codes protection.
- 3. The PV denotes permanent ventilation and must be provided above alldoors and windows where indicated.
- 4. All walls less than 200mm thick are to be reinforced with hoop iron sheet every alternate course.
- 5. All reinforced concrete works to be done according to structural detail drawings

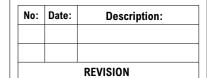




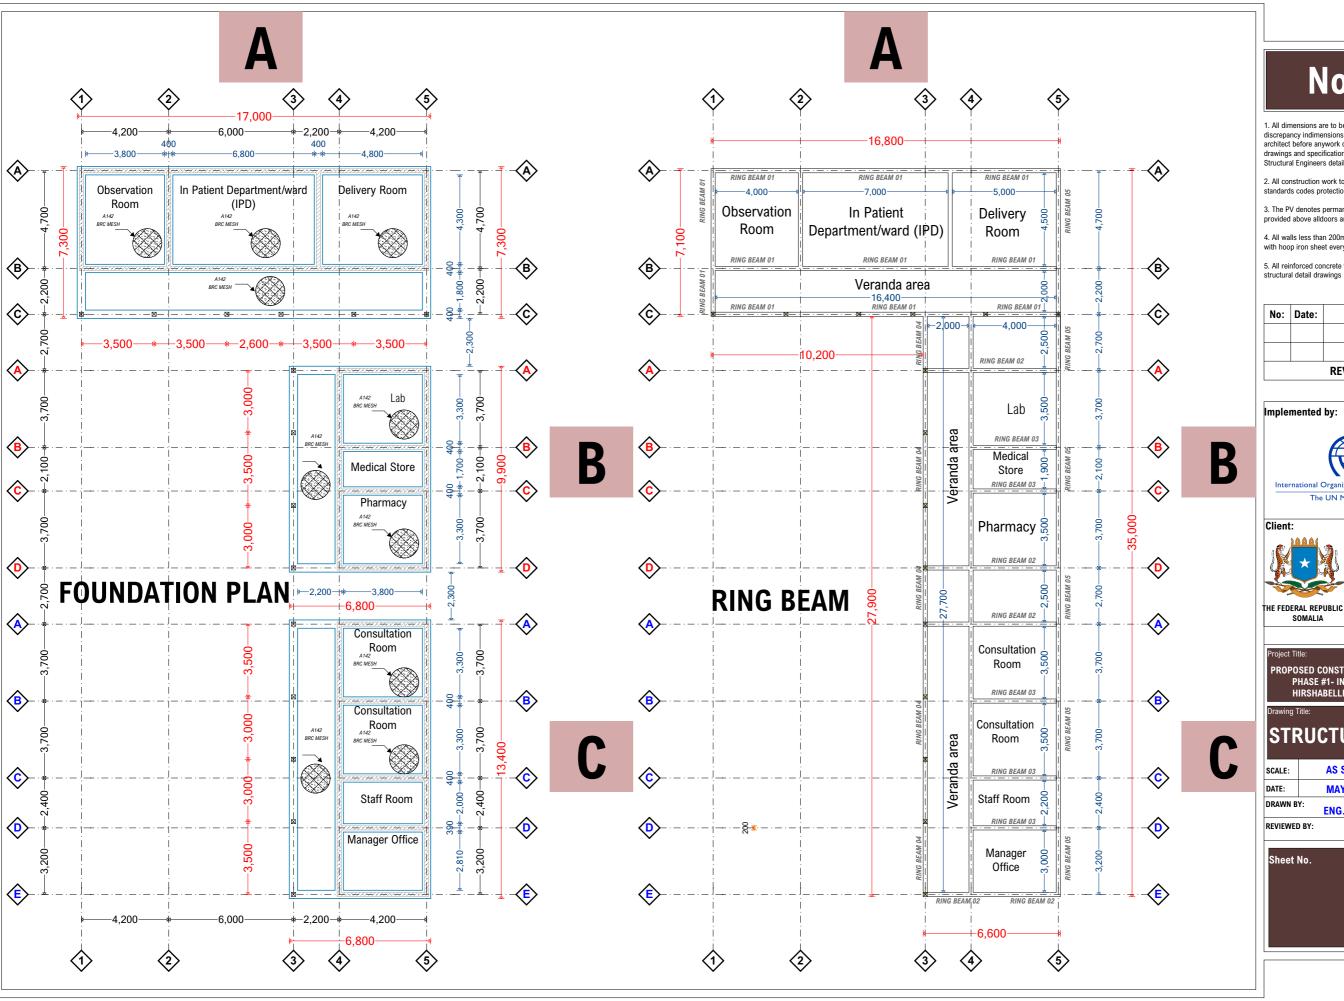

- discrepancy indimensions is to be reported to the architect before anywork commence. The Architect's drawings and specifications over rule any other. the Structural Engineers detail drawings.
- 2. All construction work to comply with the international standards codes protection.
- 3. The PV denotes permanent ventilation and must be provided above alldoors and windows where indicated.
- 4. All walls less than 200mm thick are to be reinforced with hoop iron sheet every alternate course.
- 5. All reinforced concrete works to be done according to


No:	Date:	Description:
		DEVISION



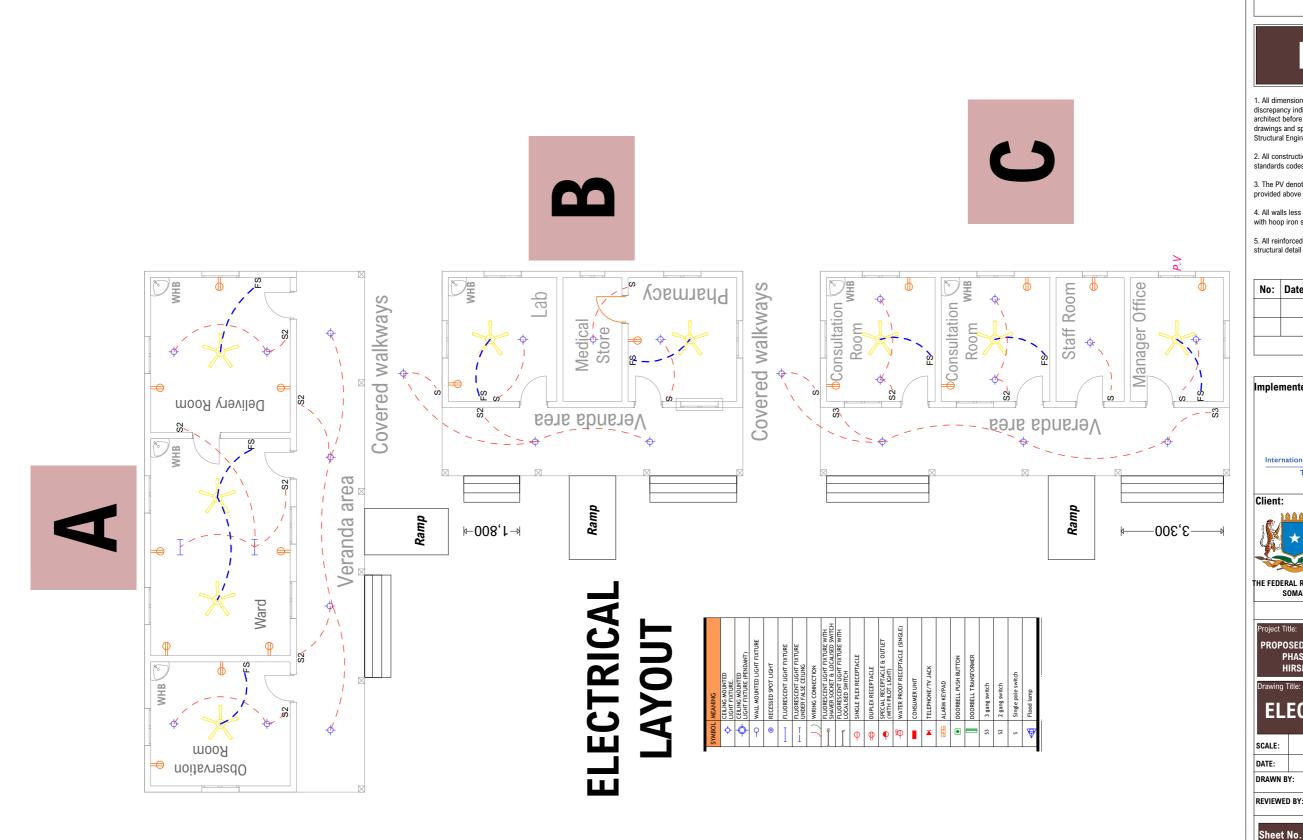

- All dimensions are to be checked on site. Any discrepancy indimensions is to be reported to the architect before anywork commence. The Architect's drawings and specifications over rule any other, the Structural Engineers detail drawings.
- 2. All construction work to comply with the international standards codes protection.
- 3. The PV denotes permanent ventilation and must be provided above alldoors and windows where indicated.
- 4. All walls less than 200mm thick are to be reinforced with hoop iron sheet every alternate course.
- 5. All reinforced concrete works to be done according to structural detail drawings

No:	Date:	Description:			
	REVISION				

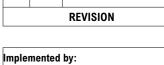



International Organization for Migration (IOM) The UN Migration Agency

Client:





THE FEDERAL REPUBLIC OF SOMALIA

HIRSHABELLE STATE, BALCAD DISTRICT

PROPOSED CONSTRUCTION OF HOSPITAL-PHASE #1- IN BALAD DISTRICT, HIRSHABELLE STATE, SOMALIA

### **ELECTRICAL PLAN**

**AS SHOWN** SCALE: DATE: **MAY 2019** 

DRAWN BY:

**ENG. Duale Salah** REVIEWED BY:









- All dimensions are to be checked on site.Any discrepancy indimensions is to be reported to the architect before anywork commence.The Architect's drawings and specifications over rule any other. the Structural Engineers detail drawings.
- 2. All construction work to comply with the international standards codes protection.
- 3. The PV denotes permanent ventilation and must be provided above alldoors and windows where indicated.
- 4. All walls less than 200mm thick are to be reinforced with hoop iron sheet every alternate course.
- 5. All reinforced concrete works to be done according to structural detail drawings

	No:	Date:	Description:
ł			REVISION

Implemented by:



International Organization for Migration (IOM) The UN Migration Agency

Client:





THE FEDERAL REPUBLIC OF SOMALIA HIRSHABELLE STATE, BALCAD DISTRICT

PROPOSED CONSTRUCTION OF HOSPITAL-Phase #1- in Balad District, Hirshabelle State, Somalia

3D-01

**ENG. Duale Salah** 

**AS SHOWN** SCALE: DATE: **MAY 2019** DRAWN BY:

REVIEWED BY:









- All dimensions are to be checked on site.Any discrepancy indimensions is to be reported to the architect before anywork commence.The Architect's drawings and specifications over rule any other. the Structural Engineers detail drawings.
- 2. All construction work to comply with the international standards codes protection.
- 3. The PV denotes permanent ventilation and must be provided above alldoors and windows where indicated.
- 4. All walls less than 200mm thick are to be reinforced with hoop iron sheet every alternate course.
- 5. All reinforced concrete works to be done according to structural detail drawings

	No:	Date:	Description:
Ī			
ł			REVISION

Implemented by:



International Organization for Migration (IOM) The UN Migration Agency






THE FEDERAL REPUBLIC OF SOMALIA HIRSHABELLE STATE, BALCAD DISTRICT

PROPOSED CONSTRUCTION OF HOSPITAL-Phase #1- in Balad District, Hirshabelle State, Somalia

3D-02

**AS SHOWN** SCALE: DATE: **MAY 2019** DRAWN BY: **ENG. Duale Salah** 

REVIEWED BY:

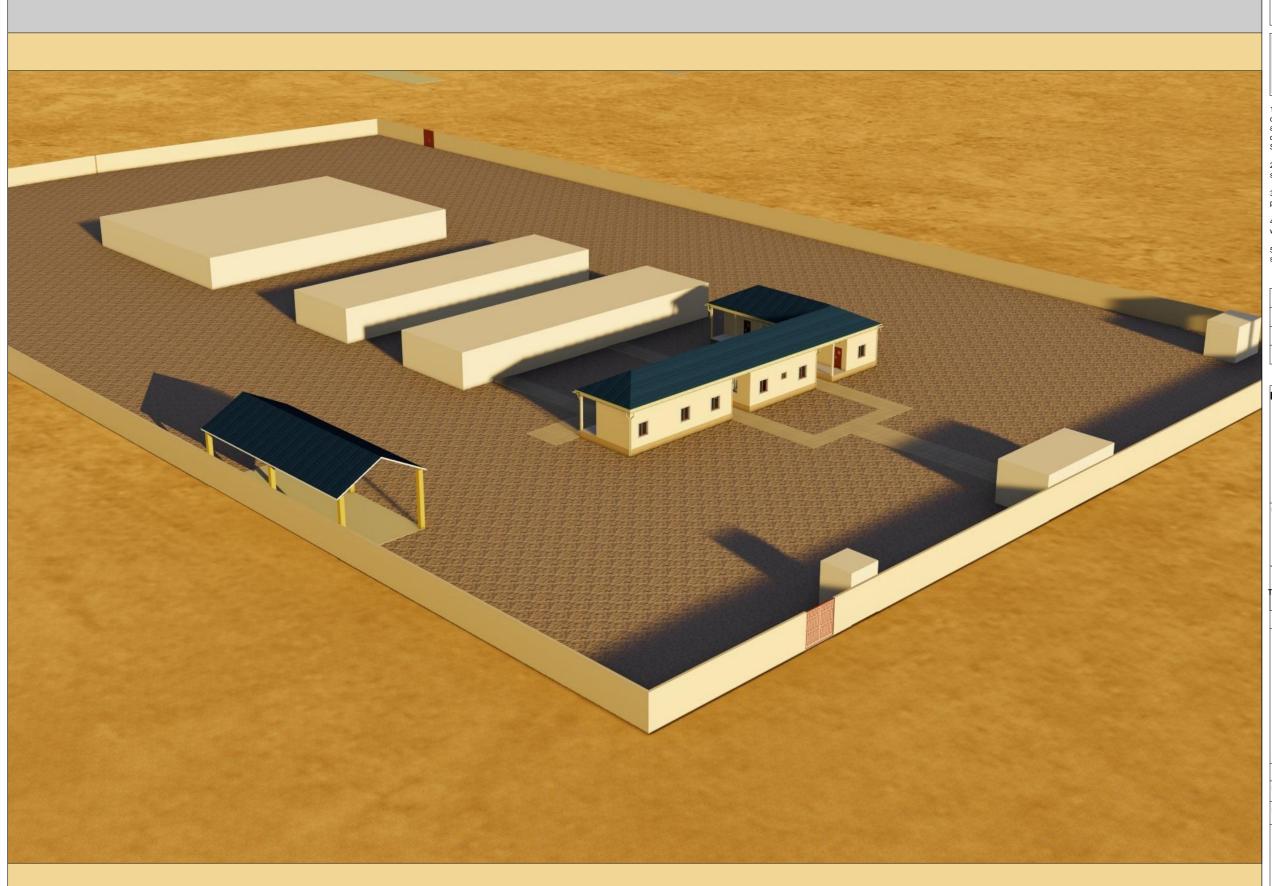

- All dimensions are to be checked on site.Any discrepancy indimensions is to be reported to the architect before anywork commence.The Architect's drawings and specifications over rule any other. the Structural Engineers detail drawings.
- 2. All construction work to comply with the international standards codes protection.
- 3. The PV denotes permanent ventilation and must be provided above alldoors and windows where indicated.
- 4. All walls less than 200mm thick are to be reinforced with hoop iron sheet every alternate course.
- 5. All reinforced concrete works to be done according to structural detail drawings

	No:	Date:	Description:
ľ			REVISION

Implemented by:



International Organization for Migration (IOM)

The UN Migration Agency

Client:





THE FEDERAL REPUBLIC OF SOMALIA HIRSHABELLE STATE, BALCAD DISTRICT

PROPOSED CONSTRUCTION OF HOSPITAL-Phase #1- in Balad District, Hirshabelle State, Somalia

3D-03

**AS SHOWN** SCALE: DATE: **MAY 2019** 

DRAWN BY:

**ENG. Duale Salah** 

REVIEWED BY:



- All dimensions are to be checked on site.Any discrepancy indimensions is to be reported to the architect before anywork commence.The Architect's drawings and specifications over rule any other. the Structural Engineers detail drawings.
- 2. All construction work to comply with the international standards codes protection.
- 3. The PV denotes permanent ventilation and must be provided above alldoors and windows where indicated.
- 4. All walls less than 200mm thick are to be reinforced with hoop iron sheet every alternate course.
- 5. All reinforced concrete works to be done according to structural detail drawings

	No:	Date:	Description:
-			REVISION

### Implemented by:



International Organization for Migration (IOM)

The UN Migration Agency

#### Client:





THE FEDERAL REPUBLIC OF SOMALIA HIRSHABELLE STATE, BALCAD DISTRICT

PROPOSED CONSTRUCTION OF HOSPITAL-Phase #1- in Balad District, Hirshabelle State, Somalia

3D-04

**AS SHOWN** SCALE: DATE: **MAY 2019** 

DRAWN BY:

**ENG. Duale Salah** 

REVIEWED BY:



- All dimensions are to be checked on site.Any discrepancy indimensions is to be reported to the architect before anywork commence.The Architect's drawings and specifications over rule any other. the Structural Engineers detail drawings.
- 2. All construction work to comply with the international standards codes protection.
- 3. The PV denotes permanent ventilation and must be provided above alldoors and windows where indicated.
- 4. All walls less than 200mm thick are to be reinforced with hoop iron sheet every alternate course.
- 5. All reinforced concrete works to be done according to structural detail drawings

No:	Date:	Description:		
REVISION				

Implemented by:



International Organization for Migration (IOM)

The UN Migration Agency

Client:



THE FEDERAL REPUBLIC OF SOMALIA HIRSHABELLE STATE, BALCAD DISTRICT

PROPOSED CONSTRUCTION OF HOSPITAL-Phase #1- in Balad District, Hirshabelle State, Somalia

3D-05

**AS SHOWN** SCALE: DATE: **MAY 2019** 

DRAWN BY:

**ENG. Duale Salah** 

REVIEWED BY:



- All dimensions are to be checked on site.Any discrepancy indimensions is to be reported to the architect before anywork commence.The Architect's drawings and specifications over rule any other. the Structural Engineers detail drawings.
- 2. All construction work to comply with the international standards codes protection.
- 3. The PV denotes permanent ventilation and must be provided above alldoors and windows where indicated.
- 4. All walls less than 200mm thick are to be reinforced with hoop iron sheet every alternate course.
- 5. All reinforced concrete works to be done according to structural detail drawings

l	No:	Date:	Description:
		•	REVISION

Implemented by:



International Organization for Migration (IOM)

The UN Migration Agency

Client:





THE FEDERAL REPUBLIC OF SOMALIA HIRSHABELLE STATE, BALCAD DISTRICT

Project Title:

PROPOSED CONSTRUCTION OF HOSPITAL-Phase #1- in Balad District, Hirshabelle State, Somalia

3D-06

**AS SHOWN** SCALE: DATE: **MAY 2019** 

DRAWN BY:

**ENG. Duale Salah** 

REVIEWED BY:



- All dimensions are to be checked on site.Any discrepancy indimensions is to be reported to the architect before anywork commence.The Architect's drawings and specifications over rule any other. the Structural Engineers detail drawings.
- 2. All construction work to comply with the international standards codes protection.
- 3. The PV denotes permanent ventilation and must be provided above alldoors and windows where indicated.
- 4. All walls less than 200mm thick are to be reinforced with hoop iron sheet every alternate course.
- 5. All reinforced concrete works to be done according to structural detail drawings

No:	Date:	Description:		
REVISION				

Implemented by:



International Organization for Migration (IOM)

The UN Migration Agency

Client:





THE FEDERAL REPUBLIC OF SOMALIA HIRSHABELLE STATE, BALCAD DISTRICT

PROPOSED CONSTRUCTION OF HOSPITAL-Phase #1- in Balad District, Hirshabelle State, Somalia

3D-07

**AS SHOWN** SCALE: DATE: **MAY 2019** 

DRAWN BY:

ENG. Duale Salah

REVIEWED BY: