

- All dimensions are to be checked on site. Any discrepancy indimensions is to be reported to the architect before anywork commence. The Architect's drawings and specifications over rule any other. the Structural Engineers detail drawings.
- All construction work to comply with the international standards codes protection.
- The PV denotes permanent ventilation and must be provided above alldoors and windows where indicated.
- 4. All walls less than 200mm thick are to be reinforced with hoop iron sheet every alternate course.
- 5. All reinforced concrete works to be done according to structural detail drawings

		No:	Date:	Description:
ı				REVISION

Implemented by:



Client



THE FEDERAL REPUI

REPUBLIC HIRSHABLE STA

Project Title

PROPOSED OF CONSTRUCTION MATABAN MAIN MARKET

Drawing Tit

Drawing Index

SCALE: AS SHOWN

DATE: MARCH 2019

ESIGN & ENG. M.Awil

REVIEWED BY:



- All dimensions are to be checked on site. Any discrepancy indimensions is to be reported to the architect before anywork commence. The Architect's drawings and specifications over rule any other. the Structural Engineers detail drawings.
- 2. All construction work to comply with the international standards codes protection.
- 3. The PV denotes permanent ventilation and must be provided above alldoors and windows where indicated.
- 4. All walls less than 200mm thick are to be reinforced with hoop iron sheet every alternate course.
- 5. All reinforced concrete works to be done according to structural detail drawings

	No:	Date:	Description:
			REVISION

Implemented by:







THE FEDERAL REPUBLIC HIRSHABLE STATE,
OF SOMALIA MATABAN DISTRICT

Project Title:

PROPOSED OF CONSTRUCTION MATABAN MAIN MARKET.

Drawing Title:

Site Location.

AS SHOWN

DATE: MARCH 2019

DESIGN & DRAWN BY: ENG. M.Awil

REVIEWED BY:

9 Feb 2019 13:13:43 5.198898031376302N 45.52528942935169E



9 Feb 2019 13:27:16 5.198769578710198N 45.52537861280143E







Notes

- All dimensions are to be checked on site. Any discrepancy indimensions is to be reported to the architect before anywork commence. The Architect's drawings and specifications over rule any other. the Structural Engineers detail drawings.
- 2. All construction work to comply with the international standards codes protection.
- 3. The PV denotes permanent ventilation and must be provided above alldoors and windows where indicated.
- 4. All walls less than 200mm thick are to be reinforced with hoop iron sheet every alternate course.
- 5. All reinforced concrete works to be done according to structural detail drawings

No:	Date:	Description:
		REVISION

Implemented by:



Client



THE FEDERAL REPUBLIC HIRSHABLE STATE,
OF SOMALIA MATABAN DISTRICT

Project Title:

PROPOSED OF CONSTRUCTION MATABAN MAIN MARKET.

Drawing Title:

Existing Pictures

SCALE: AS SHOWN


DATE: MARCH 2019

DESIGN & ENG. M.Awil

REVIEWED BY:

Sheet No.

ΔΞ

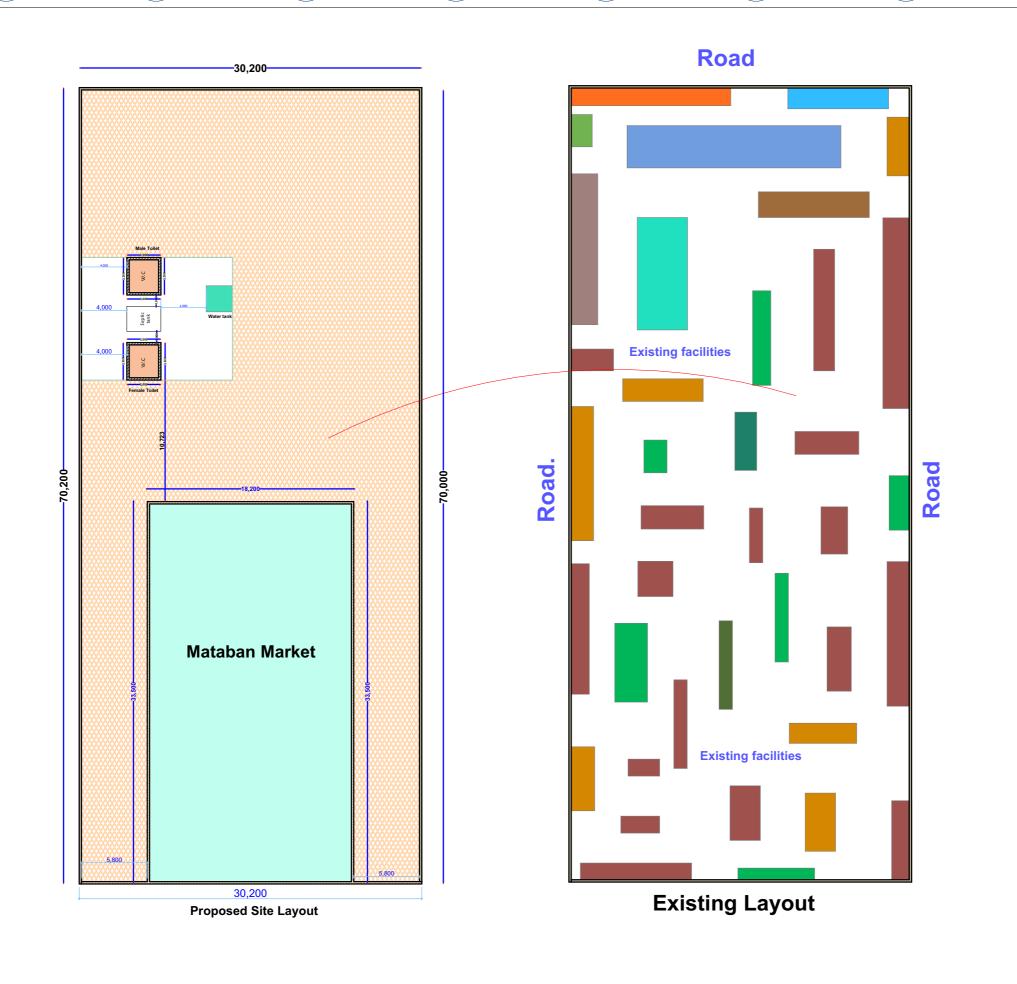

- All dimensions are to be checked on site. Any discrepancy indimensions is to be reported to the architect before anywork commence. The Architect's drawings and specifications over rule any other. the Structural Engineers detail drawings.
- 2. All construction work to comply with the international standards codes protection.
- 3. The PV denotes permanent ventilation and must be provided above alldoors and windows where indicated.
- 4. All walls less than 200mm thick are to be reinforced with hoop iron sheet every alternate course.
- 5. All reinforced concrete works to be done according

	No:	Date:	Description:
			REVISION

Implemented by:







THE FEDERAL REPUBLIC HIRSHABLE STATE,
OF SOMALIA MATABAN DISTRICT

Project Title:

PROPOSED OF CONSTRUCTION MATABAN MAIN MARKET.


Drawing Title:

Site Layout

AS SHOWN DATE:

MARCH 2019 ENG. M.Awil

REVIEWED BY:

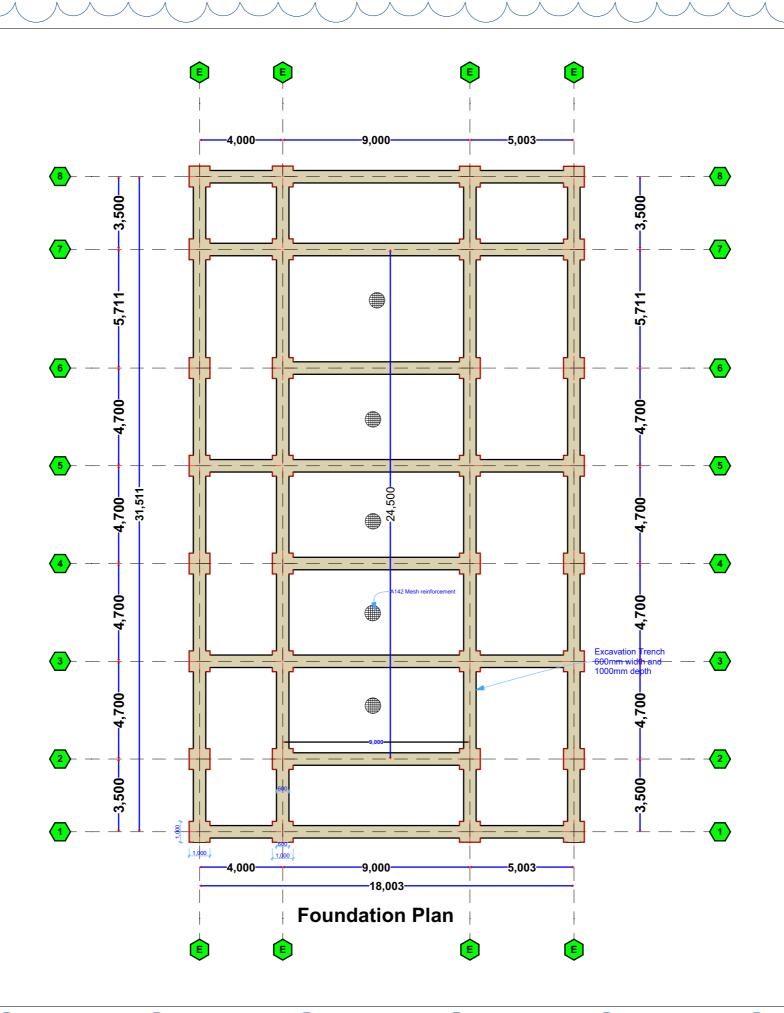

- 1. All dimensions are to be checked on site. Any discrepancy indimensions is to be reported to the architect before anywork commence. The Architect's drawings and specifications over rule any other. the Structural Engineers detail drawings.
- 2. All construction work to comply with the international standards codes protection.
- 3. The PV denotes permanent ventilation and must be provided above alldoors and windows where indicated.
- 4. All walls less than 200mm thick are to be reinforced with hoop iron sheet every alternate course.
- 5. All reinforced concrete works to be done according to structural detail drawings

	No:	Date:	Description:
			REVISION

Implemented by:







THE FEDERAL REPUBLIC HIRSHABLE STATE,
OF SOMALIA MATABAN DISTRICT

Project Title:


PROPOSED OF CONSTRUCTION MATABAN MAIN MARKET.

Drawing Title:

Foundation Plan

AS SHOWN DATE: MARCH 2019 DESIGN & DRAWN BY: ENG. M.Awil

REVIEWED BY:

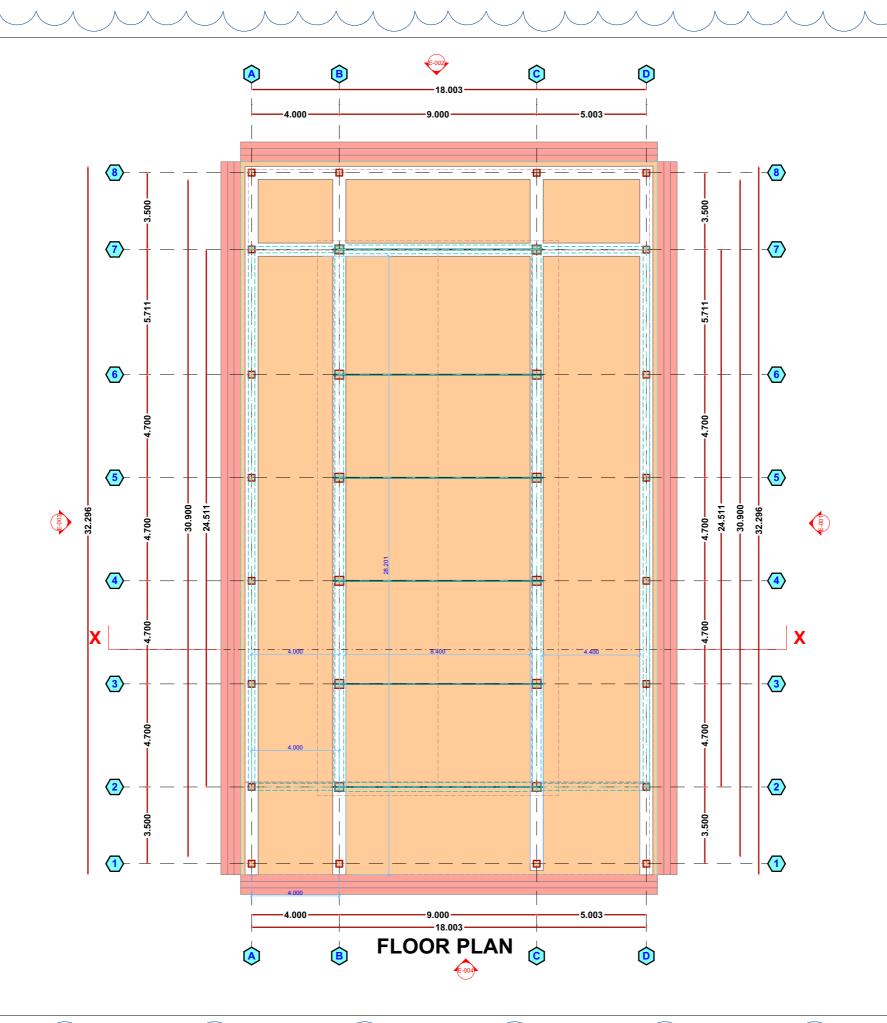

- 1. All dimensions are to be checked on site. Any discrepancy indimensions is to be reported to the architect before anywork commence. The Architect's drawings and specifications over rule any other. the Structural Engineers detail drawings.
- 2. All construction work to comply with the international standards codes protection.
- 3. The PV denotes permanent ventilation and must be provided above alldoors and windows where indicated.
- 4. All walls less than 200mm thick are to be reinforced with hoop iron sheet every alternate course.
- 5. All reinforced concrete works to be done according to structural detail drawings

	No:	Date:	Description:
			REVISION









THE FEDERAL REPUBLIC HIRSHABLE STATE,
OF SOMALIA MATABAN DISTRICT

Project Title:

PROPOSED OF CONSTRUCTION MATABAN MAIN MARKET.

Drawing Title:

Floor Plan

AS SHOWN SCALE: DATE:

MARCH 2019 DESIGN & DRAWN BY: ENG. M.Awil

REVIEWED BY:

22* Roof Pitch 22* Roof Pitch ELEVATION_002 ELEVATION_001 -600mm high precast ventilation blocks above the ring beams -wall paints should be white __22* Roof Pitch 1700 000 ELEVATION_004 ELEVATION_003

Notes

- 1. All dimensions are to be checked on site.Any discrepancy indimensions is to be reported to the architect before anywork commence. The Architect's drawings and specifications over rule any other. the Structural Engineers detail drawings.
- 2. All construction work to comply with the international standards codes protection.
- 3. The PV denotes permanent ventilation and must be provided above alldoors and windows where indicated.
- 4. All walls less than 200mm thick are to be reinforced with hoop iron sheet every alternate course.
- 5. All reinforced concrete works to be done according to structural detail drawings

No:	Date:	Description:
		REVISION

Implemented by:





THE FEDERAL REPUBLIC HIRSHABLE STATE,
OF SOMALIA MATABAN DISTRICT

Project Title:

PROPOSED OF CONSTRUCTION MATABAN MAIN MARKET.

Drawing Title:


Elevation View

AS SHOWN SCALE:

DATE: MARCH 2019

DESIGN & DRAWN BY: ENG. M.Awil

REVIEWED BY:

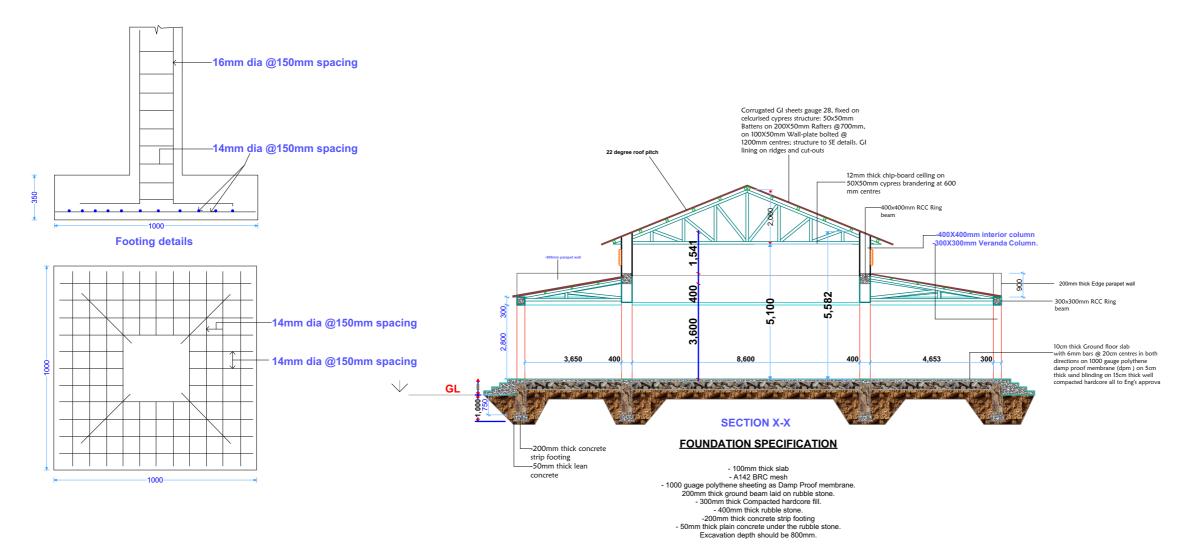

- 1. All dimensions are to be checked on site.Any discrepancy indimensions is to be reported to the architect before anywork commence. The Architect's drawings and specifications over rule any other. the Structural Engineers detail drawings.
- 2. All construction work to comply with the international standards codes protection.
- 3. The PV denotes permanent ventilation and must be provided above alldoors and windows where indicated.
- 4. All walls less than 200mm thick are to be reinforced with hoop iron sheet every alternate course.
- 5. All reinforced concrete works to be done according to structural detail drawings

No:	Date:	Description:
		REVISION

Implemented by:







THE FEDERAL REPUBLIC HIRSHABLE STATE,
OF SOMALIA MATABAN DISTRICT

Project Title:

PROPOSED OF CONSTRUCTION MATABAN MAIN MARKET.


Drawing Title:

Section View

AS SHOWN SCALE: DATE: **MARCH 2019**

DESIGN & DRAWN BY: ENG. M.Awil

REVIEWED BY:

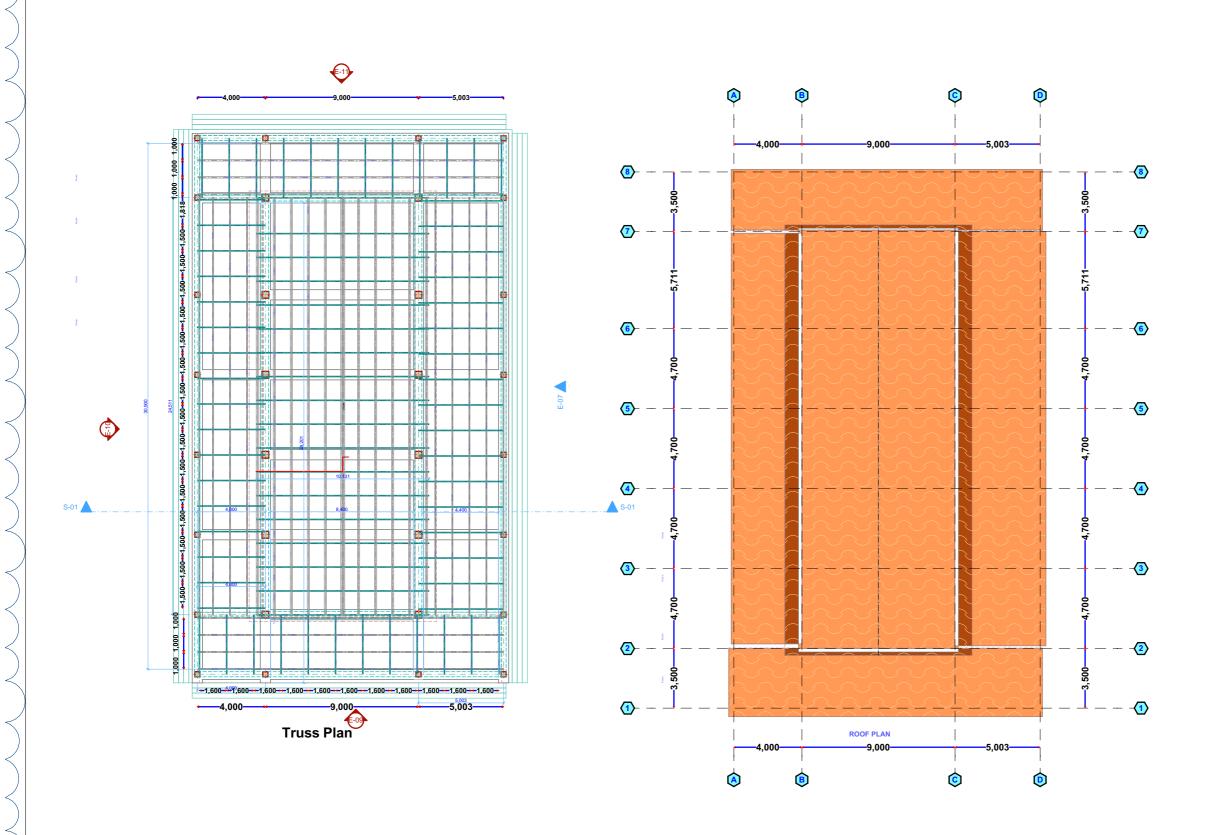

- 1. All dimensions are to be checked on site. Any discrepancy indimensions is to be reported to the architect before anywork commence. The Architect's drawings and specifications over rule any other, the Structural Engineers detail drawings.
- 2. All construction work to comply with the international standards codes protection.
- 3. The PV denotes permanent ventilation and must be provided above alldoors and windows where indicated.
- 4. All walls less than 200mm thick are to be reinforced with hoop iron sheet every alternate course.
- 5. All reinforced concrete works to be done according to structural detail drawings

	No:	Date:	Description:
			REVISION

Implemented by:



Client



THE FEDERAL REPUBLIC HIRSHABLE STATE,
OF SOMALIA MATABAN DISTRICT

Project Title:

PROPOSED OF CONSTRUCTION MATABAN MAIN MARKET.

Drawing Title:

Roof and Truss Plan

SCALE: AS SHOWN


DATE: MARCH 2019


DESIGN & ENG. M.AWII

REVIEWED BY:

Sheet No.

1

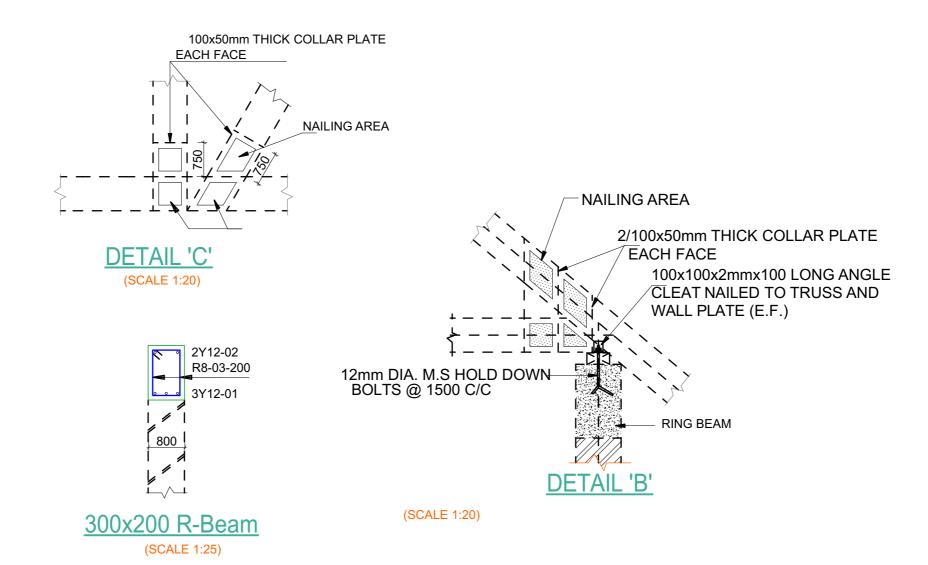

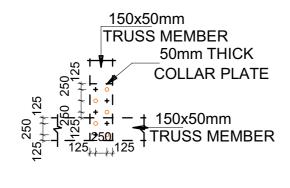

(SCALE 1:20)


2/100x50mm OR

FACE

100x50mm THICK

COLLAR PLATE EACH

NAILING AREA

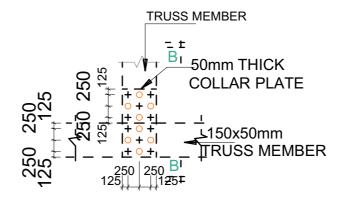

TYPICAL NAILING PATTERN

(SCALE 1:20)

Notes

- All dimensions are to be checked on site. Any discrepancy indimensions is to be reported to the architect before anywork commence. The Architect's drawings and specifications over rule any other. the Structural Engineers detail drawings.
- All construction work to comply with the international standards codes protection.
- The PV denotes permanent ventilation and must be provided above alldoors and windows where indicated.
- 4. All walls less than 200mm thick are to be reinforced with hoop iron sheet every alternate course.
- 5. All reinforced concrete works to be done according to structural detail drawings

	No:	Date:	Description:
			REVISION

Implemented by:



Client





THE FEDERAL REPUBLIC
OF SOMALIA

HIRSHABLE STATE, MATABAN DISTRICT

Project Title:

PROPOSED OF CONSTRUCTION MATABAN MAIN MARKET.

Drawing Title:

Truss details

SCALE: AS SHOWN


DATE: MARCH 2019

DESIGN & ENG. M.Awil

REVIEWED BY:

Sheet No.

E

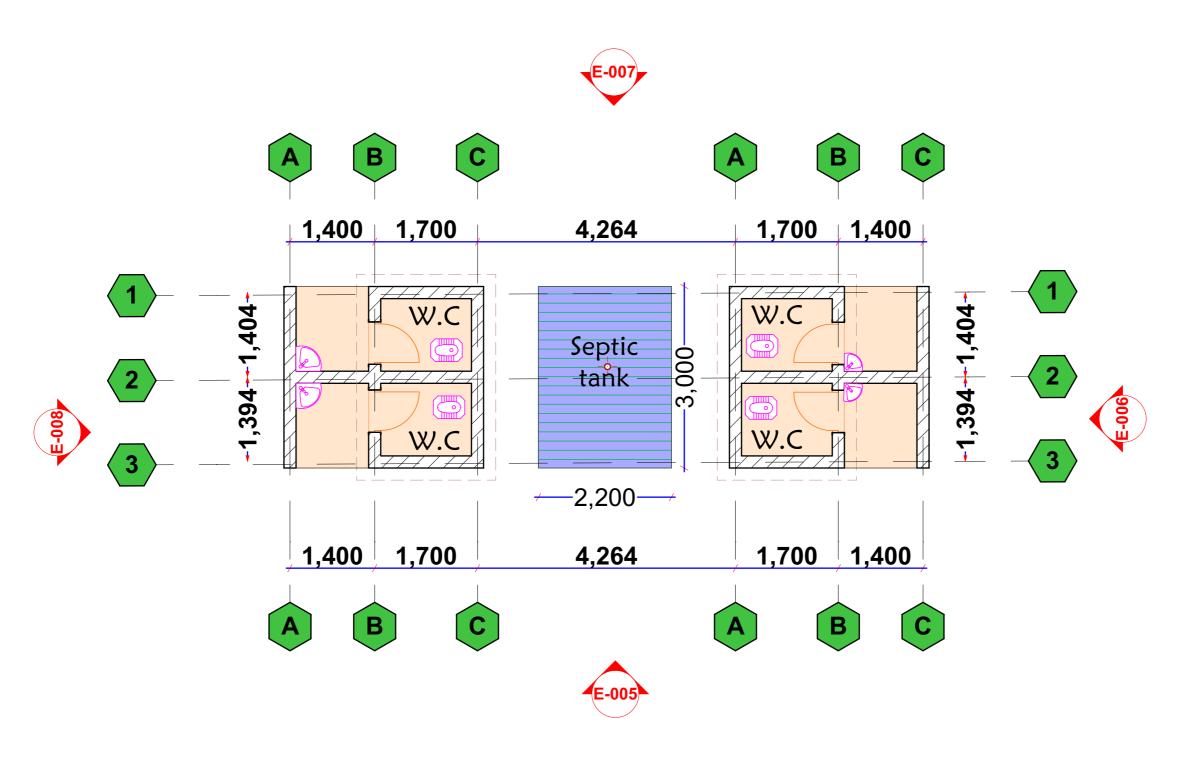

- 1. All dimensions are to be checked on site. Any discrepancy indimensions is to be reported to the architect before anywork commence. The Architect's drawings and specifications over rule any other. the Structural Engineers detail drawings.
- 2. All construction work to comply with the $international\ standards\ codes\ protection.$
- 3. The PV denotes permanent ventilation and must be provided above alldoors and windows where indicated.
- 4. All walls less than 200mm thick are to be reinforced with hoop iron sheet every alternate course.
- 5. All reinforced concrete works to be done according to structural detail drawings

No:	Date:	Description:
		REVISION

Implemented by:



Client:



THE FEDERAL REPUBLIC HIRSHABLE STATE,
OF SOMALIA MATABAN DISTRICT

Project Title:

PROPOSED OF CONSTRUCTION MATABAN MAIN MARKET.


Drawing Title:


Toilet Floor Plan.

AS SHOWN


DATE: MARCH 2019 DESIGN & DRAWN BY: ENG. M.Awil

REVIEWED BY:

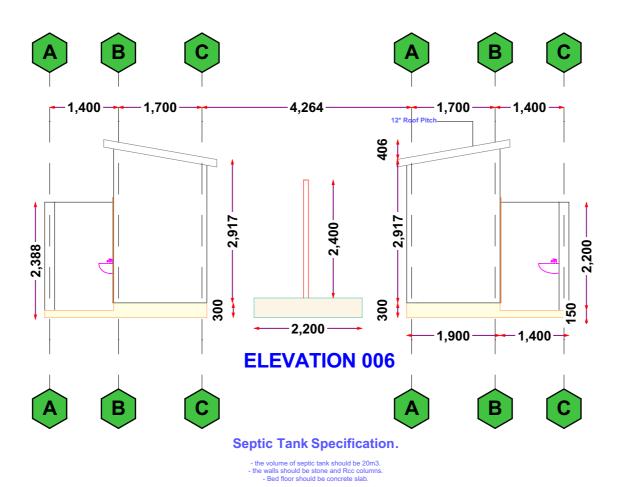

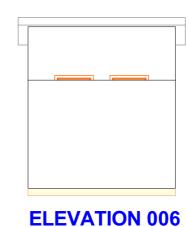

4,264 **ELEVATION 007**

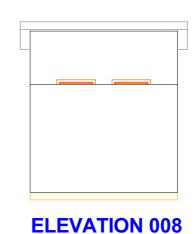

Notes

- 1. All dimensions are to be checked on site.Any discrepancy indimensions is to be reported to the architect before anywork commence. The Architect's drawings and specifications over rule any other. the Structural Engineers detail drawings.
- 2. All construction work to comply with the international standards codes protection.
- 3. The PV denotes permanent ventilation and must be provided above alldoors and windows where indicated.
- 4. All walls less than 200mm thick are to be reinforced with hoop iron sheet every alternate course.
- 5. All reinforced concrete works to be done according to structural detail drawings

	No:	Date:	Description:
			REVISION

Implemented by:







THE FEDERAL REPUBLIC HIRSHABLE STATE,
OF SOMALIA MATABAN DISTRICT

Project Title:

PROPOSED OF CONSTRUCTION MATABAN MAIN MARKET.


Drawing Title:

Toilet Elavation View

AS SHOWN

DATE: MARCH 2019 DESIGN & DRAWN BY: ENG. M.Awil

REVIEWED BY:

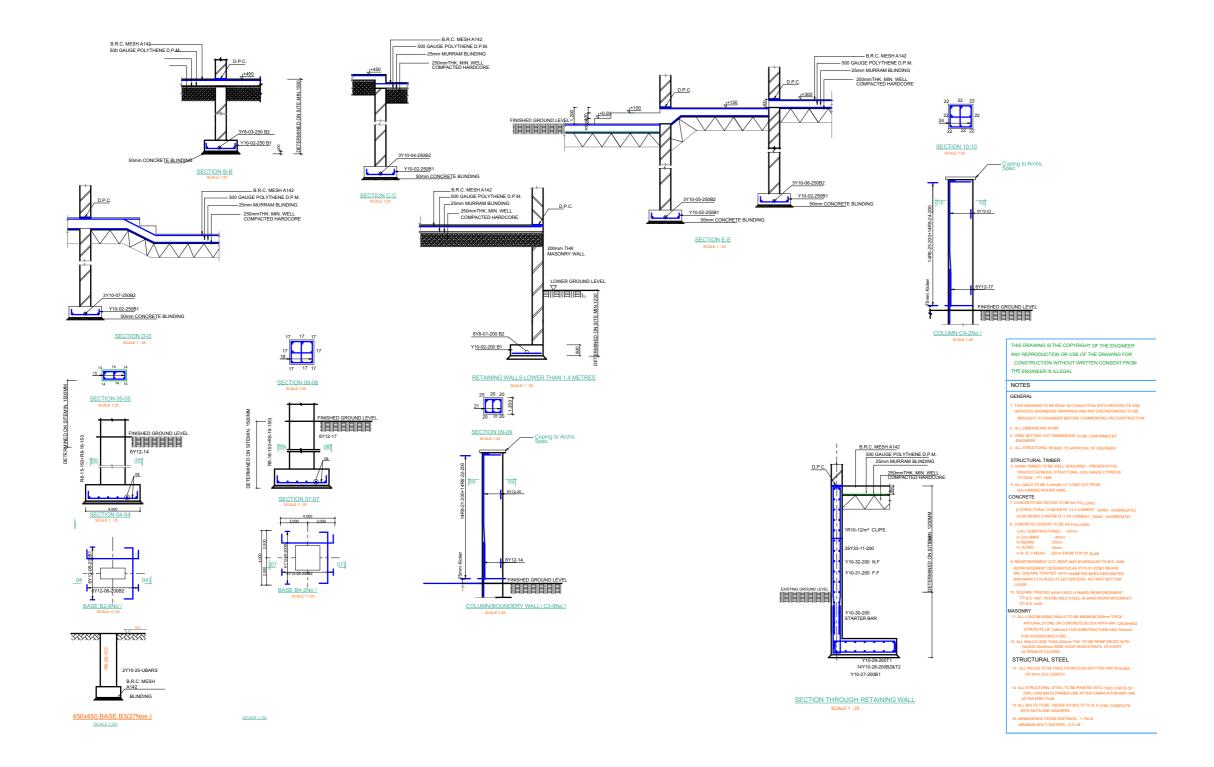

- 1. All dimensions are to be checked on site.Any discrepancy indimensions is to be reported to the architect before anywork commence. The Architect's drawings and specifications over rule any other. the Structural Engineers detail drawings.
- 2. All construction work to comply with the international standards codes protection.
- 3. The PV denotes permanent ventilation and must be provided above alldoors and windows where indicated.
- 4. All walls less than 200mm thick are to be reinforced with hoop iron sheet every alternate course.
- 5. All reinforced concrete works to be done according to structural detail drawings

	No:	Date:	Description:
			REVISION

Implemented by:







THE FEDERAL REPUBLIC HIRSHABLE STATE,
OF SOMALIA MATABAN DISTRICT

Project Title:


PROPOSED OF CONSTRUCTION MATABAN MAIN MARKET.

Drawing Title:

Details Structural

AS SHOWN SCALE: DATE: **MARCH 2019**

DESIGN & DRAWN BY: ENG. M.Awil REVIEWED BY:

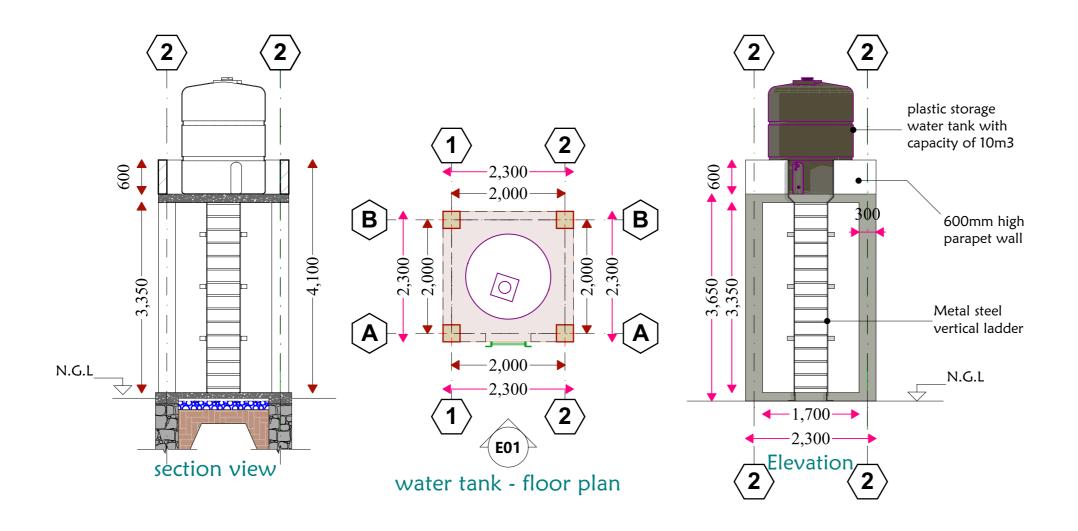

- 1. All dimensions are to be checked on site. Any discrepancy indimensions is to be reported to the architect before anywork commence. The Architect's drawings and specifications over rule any other. the Structural Engineers detail drawings.
- 2. All construction work to comply with the international standards codes protection.
- 3. The PV denotes permanent ventilation and must be provided above alldoors and windows where indicated.
- 4. All walls less than 200mm thick are to be reinforced with hoop iron sheet every alternate course.
- 5. All reinforced concrete works to be done according

	No:	Date:	Description:			
	REVISION					









THE FEDERAL REPUBLIC HIRSHABLE STATE,
OF SOMALIA MATABAN DISTRICT

Project Title:

PROPOSED OF CONSTRUCTION MATABAN MAIN MARKET.


Drawing Title:

Water tank

AS SHOWN DATE: MARCH 2019

DESIGN & DRAWN BY: ENG. M.Awil

REVIEWED BY:

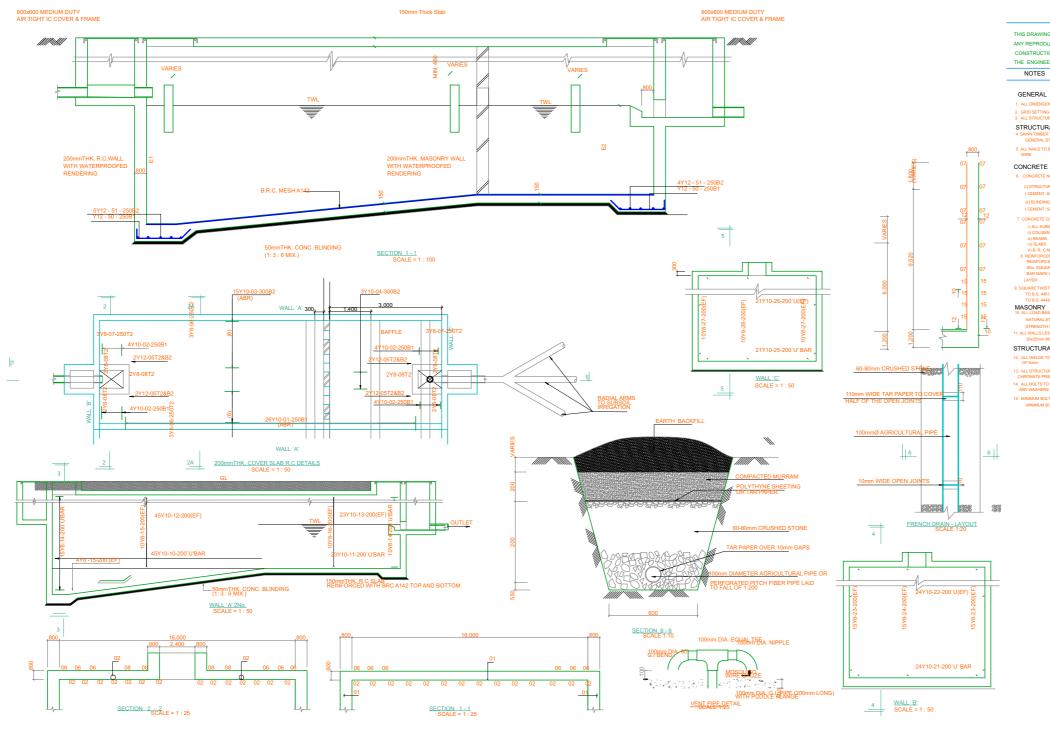

THIS DRAWING IS THE COPYRIGHT OF THE ENGINEER ANY REPRODUCTION OR USE OF THE DRAWING F CONSTRUCTION WITHOUT WRITTEN CONSENT FROM THE ENGINEER IS ILLEGAL

NOTES

STRUCTURAL TIMBER

CONCRETE

MASONRY

STRUCTURAL STEEL

Notes

- 1. All dimensions are to be checked on site.Any discrepancy indimensions is to be reported to the architect before anywork commence. The Architect's drawings and specifications over rule any other. the Structural Engineers detail drawings.
- 2. All construction work to comply with the international standards codes protection.
- 3. The PV denotes permanent ventilation and must be provided above alldoors and windows where indicated.
- 4. All walls less than 200mm thick are to be reinforced with hoop iron sheet every alternate course.
- 5. All reinforced concrete works to be done according to structural detail drawings

	No:	Date:	Description:
			REVISION

Implemented by:



Client:





THE FEDERAL REPUBLIC HIRSHABLE STATE,
OF SOMALIA MATABAN DISTRICT

Project Title:

PROPOSED OF CONSTRUCTION MATABAN MAIN MARKET.


Drawing Title:

Septic tank

AS SHOWN SCALE: DATE: MARCH 2019

DESIGN & DRAWN BY: ENG. M.Awil

REVIEWED BY:

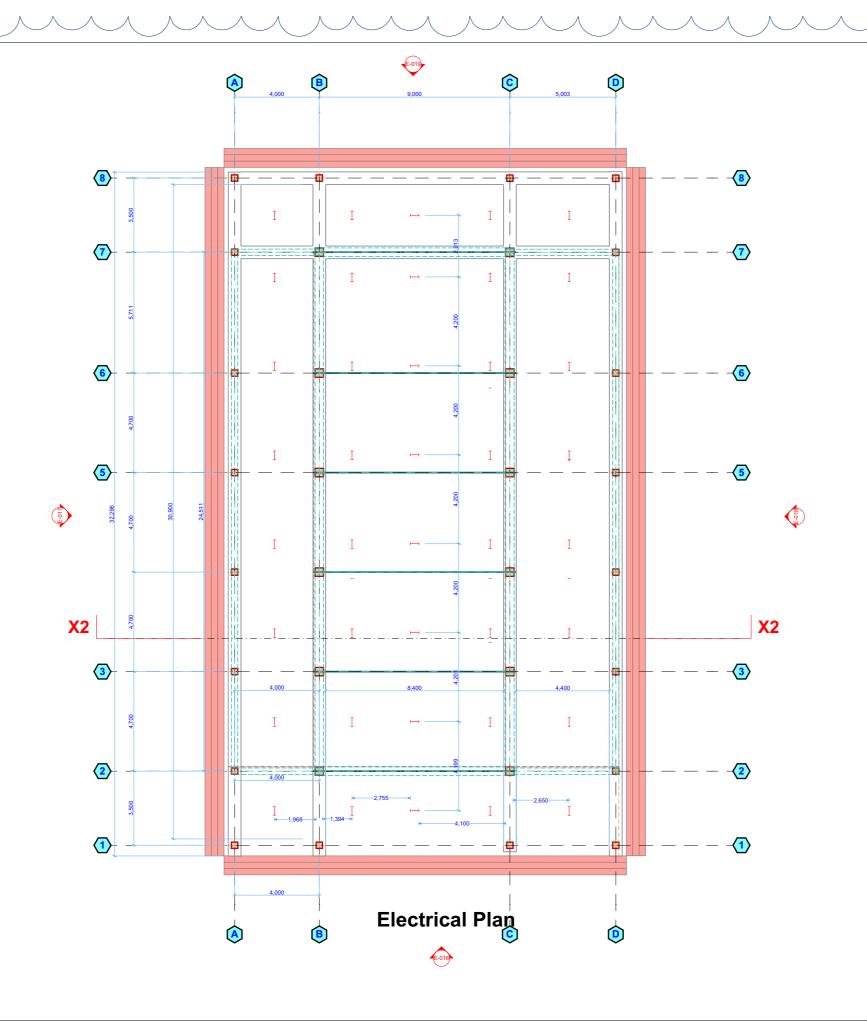

- All dimensions are to be checked on site. Any discrepancy indimensions is to be reported to the architect before anywork commence. The Architect's drawings and specifications over rule any other. the Structural Engineers detail drawings.
- 2. All construction work to comply with the international standards codes protection.
- 3. The PV denotes permanent ventilation and must be provided above alldoors and windows where indicated.
- 4. All walls less than 200mm thick are to be reinforced with hoop iron sheet every alternate course.
- 5. All reinforced concrete works to be done according to structural detail drawings

No:	Date:	Description:			
	REVISION				

Implemented by:





THE FEDERAL REPUBLIC HIRSHABLE STATE,
OF SOMALIA MATABAN DISTRICT

Project Title:

PROPOSED OF CONSTRUCTION MATABAN MAIN MARKET.

Drawing Title:

Electrical Plan

AS SHOWN DATE: **MARCH 2019** DESIGN & DRAWN BY: ENG. M.Awil

REVIEWED BY:



- All dimensions are to be checked on site. Any discrepancy indimensions is to be reported to the architect before anywork commence. The Architect's drawings and specifications over rule any other. the Structural Engineers detail drawings.
- 2. All construction work to comply with the international standards codes protection.
- 3. The PV denotes permanent ventilation and must be provided above alldoors and windows where indicated.
- 4. All walls less than 200mm thick are to be reinforced with hoop iron sheet every alternate course.
- 5. All reinforced concrete works to be done according to structural detail drawings

	No:	Date:	Description:
			REVISION

Implemented by:







THE FEDERAL REPUBLIC HIRSHABLE STATE,
OF SOMALIA MATABAN DISTRICT

Project Title:

PROPOSED OF CONSTRUCTION MATABAN MAIN MARKET

Drawing Title:

3D_01

AS SHOWN

MARCH 2019 DATE:

ENG. M.Awil

REVIEWED BY:



- 3. The PV denotes permanent ventilation and must be provided above alldoors and windows where

	No:	Date:	Description:
			REVISION





MATABAN MAIN MARKET



- All dimensions are to be checked on site. Any discrepancy indimensions is to be reported to the architect before anywork commence. The Architect's drawings and specifications over rule any other, the
- 3. The PV denotes permanent ventilation and must be provided above alldoors and windows where
- 4. All walls less than 200mm thick are to be reinforced with hoop iron sheet every alternate course.
- 5. All reinforced concrete works to be done according

	No:	Date:	Description:
			REVISION





HIRSHABLE STATE, MATABAN DISTRICT

PROPOSED OF CONSTRUCTION MATABAN MAIN MARKET

3D_View_03

ENG. M.Awil